

FOR PAINT SEE GENERAL NOTES ON DWG. S-995-76

ELEVATION A

ELEVATION B


ELEVATION C - AS SHOWN

ELEVATION C1 - OPPOSITE AS SHOWN

APPROACH SLAB

APPROACH SLAB

SCALE HOUSE & PIT.

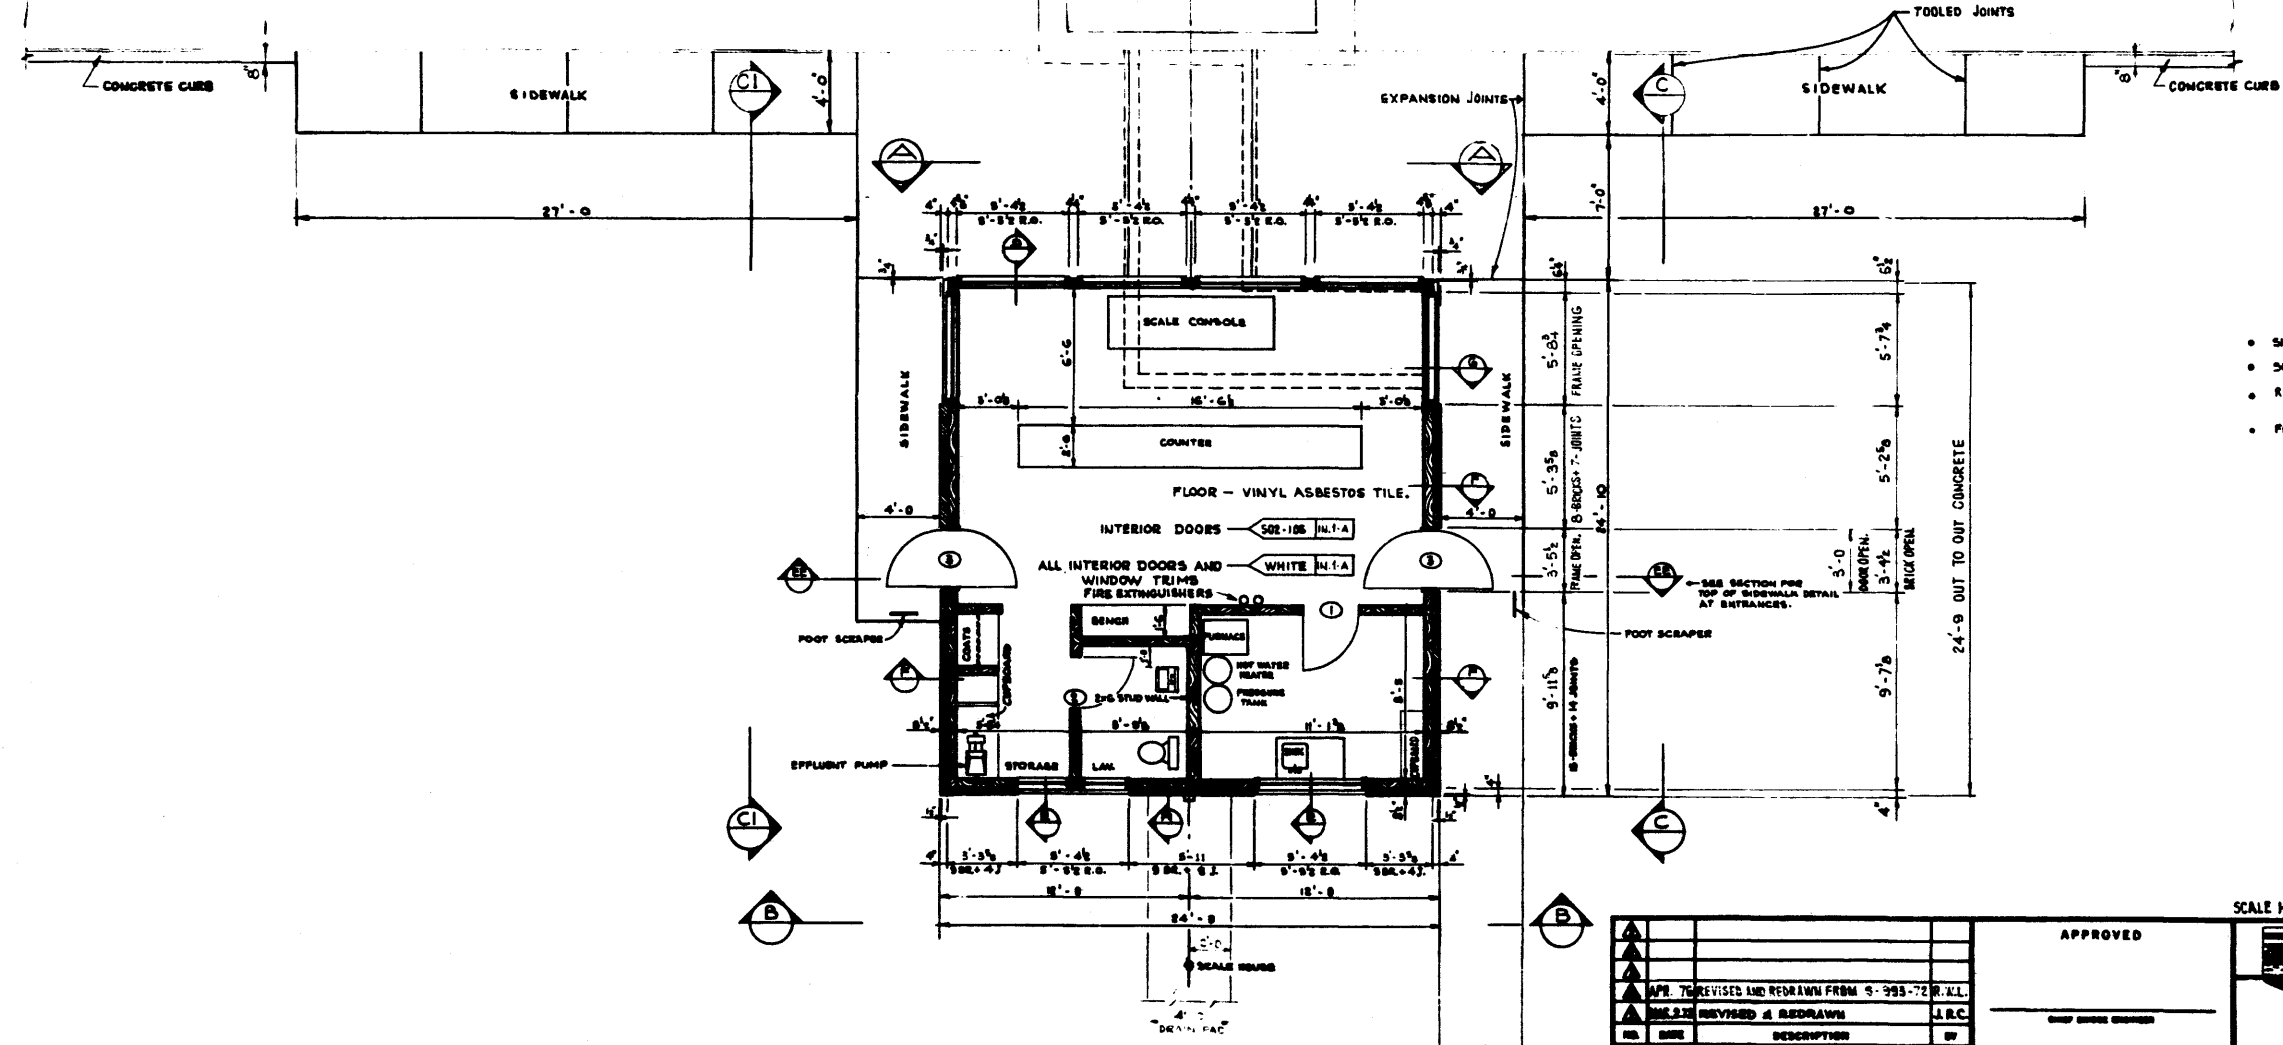

FLOOR PLAN

GENERAL NOTES

- SIDEWALK TO BE 4000 psi. CONCRETE.
- SIDEWALK TO BE GIVEN CLASS 4 SIDEWALK FINISH.
- REMOVE EXISTING CURBS ALONG APPROACH SLAB AND REPLACE AFTER GRANULAR FILL AND SLAB HAVE BEEN PLACED.
- FOR SECTION NOT SHOWN ON THIS DWG. SEE S-995-76 & S-996-76

SCALE HOUSE DETAILS TAKEN FROM R.P.M. DWG'S.

APPROVED		PROVINCE OF ALBERTA DEPARTMENT OF HIGHWAYS AND TRANSPORT BRIDGE BRANCH	
APR. 76 REVISED AND REDRAWN FROM S-993-72 R.K.L. MAY 27 1976 REVISED & REDRAWN J.R.C.		WEIGH SCALE STATION	
REVISIONS		FLOOR PLAN AND ELEVATIONS	
DESIGNED BY R.W. LYNE	DRAWN BY F.W. DUDA	DATE APR. 76	SCALE 1/4" = 1'-0"
SHEET NO. 3235 PROJECT NO. S-993-76		SHEET NO. 3235 PROJECT NO. S-993-76	